

SECTIONAL PLAN VIEW SCALE: 1:50 @ A3

SPECIFICATIONS:

- INTERNAL DIAMETER 3200mm nominal.
- METHOD OF MANUFACTURE steel mould formed with intense mechanical vibration.
- CONCRETE TYPE sulfate resistant using calcareous aggregate.
- STRENGTH 50 MPa at 28 days. Internal finish to meet AS1510 Class 2.
- WALL THICKNESS 120mm with 60mm internal cover over reinforcement. Design conforms to AS 3735
- REINFORCEMENT complies with AS/NZS 4671.
- VALVE CHAMBER full size 2200mm X 1800mm formed as one section.
- VALVES 3 x DN80 resilient seated gate valves.
 - 2 x DN80 ball type non-return valves.
- 1 x DN225 resilient seated inlet gate valve.
 PIPEWORK DN90 PN16 (SDR11) HDPE Pipework.
- 10. PUMPS 2 x Sulzer XFP80E-CB1-PE110/2 submersible pumps guiderail mounted.
- 11. ACCESS COVERS lockable hinged aluminium access covers with hinged safety grate over wet well

 12. LEVEL CONTROLS - BY OTHERS

 13. PUMP CONTROLLER - BY OTHERS

- 14. LIFTING DETAILS $4 \times 10.0t$ 'Swift-Lifts in base and $4 \times 5.0t$ in increments, valve

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В	Inlet Chamber Removed	09.10.20
Α	For Approval	06.10.20
Rev	Description	Date

FOR APPROVAL



Q-MAX PUMPING SYSTEMS PO BOX 6006 72 HIGH STREET QUEANBEYAN NSW 2620

P 02 6128 1000 F 02 6128 1055 E SALES@QMAXPUMPING.COM.AU WWW.QMAXPUMPING.COM.AU DESIGNED FOR PERFORMANCE BASED ON EXPERIENC

PRIME MOSS VALE PTY LTD

CHELSEA GARDENS SEWER PUMP STATION


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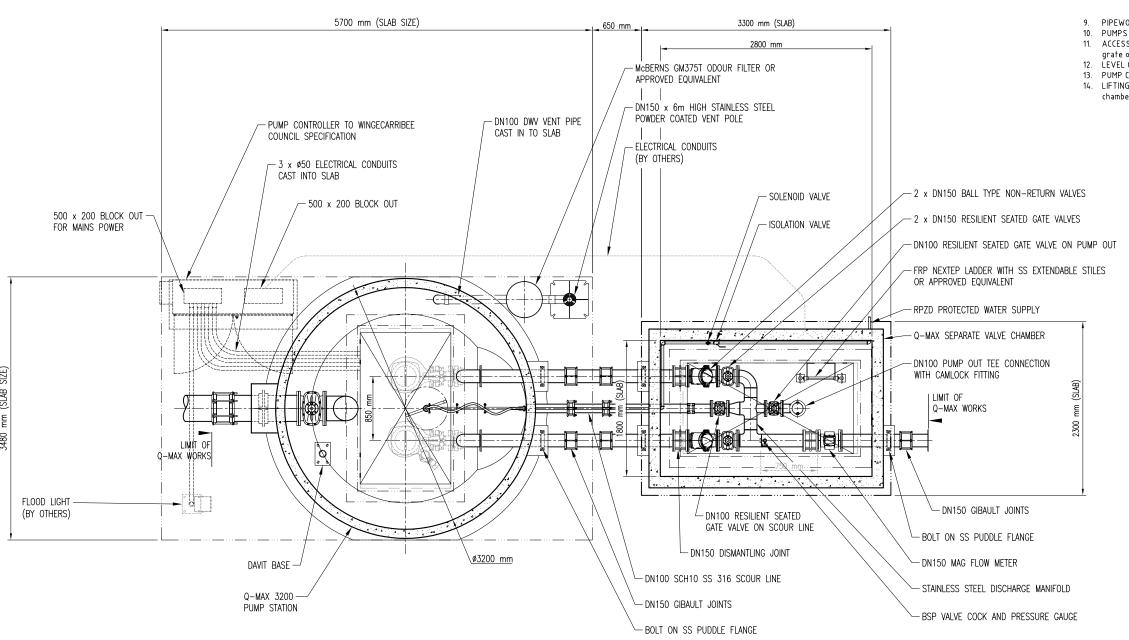
Drawn	S. SHOKRAVI	Date	0.202
Designed	D. PRIDHAM	09.1	0.202
Checked	P. PRIDHAM	Sheet	2/7
Scale	1:50	Size	А3

Q-MAX 3200 PUMP STATION **GENERAL LAYOUT** (PLAN VIEW)

В

T212/A2



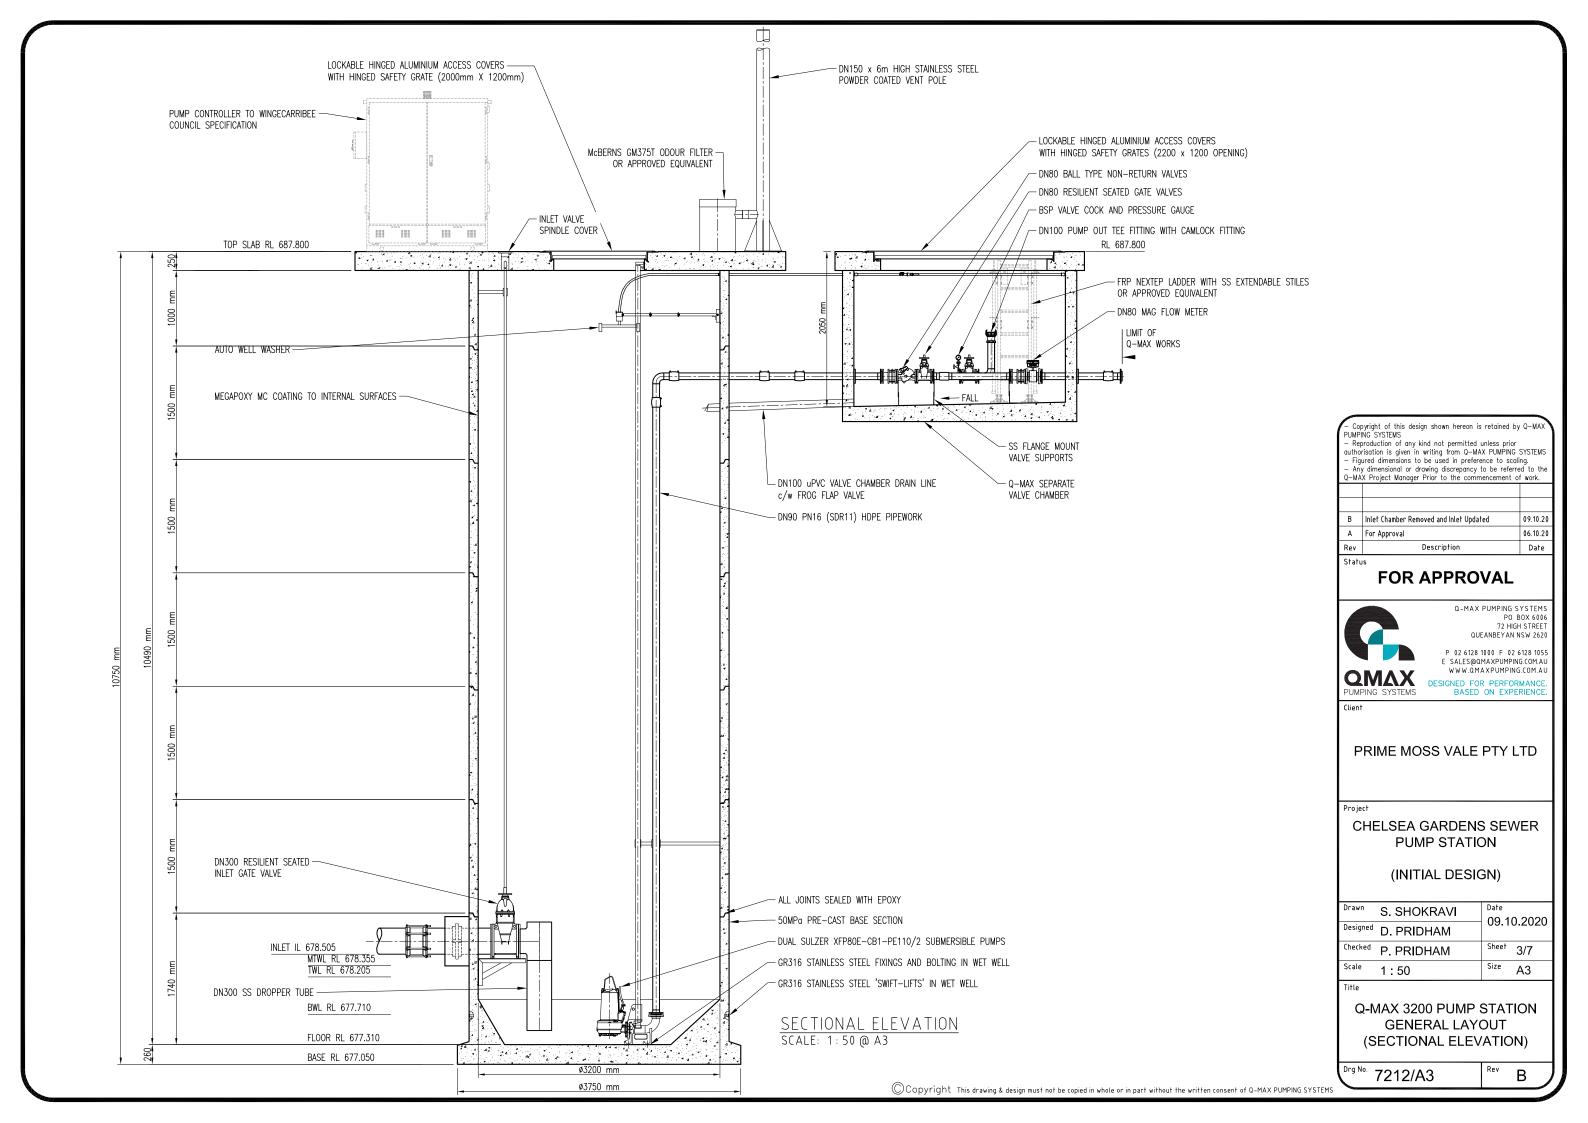

SECTIONAL PLAN VIEW SCALE: 1:50 @ A3

SPECIFICATIONS:

- INTERNAL DIAMETER 3200mm nominal.
- METHOD OF MANUFACTURE steel mould formed with intense mechanical vibration.
- CONCRETE TYPE sulfate resistant using calcareous aggregate.
- STRENGTH 50 MPa at 28 days. Internal finish to meet AS1510 Class 2.
- WALL THICKNESS 120mm with 60mm internal cover over reinforcement. Design conforms to AS 3735
- REINFORCEMENT complies with AS/NZS 4671.
- VALVE CHAMBER full size 2200mm X 1800mm formed as one section.
- VALVES 2 x DN150 resilient seated gate valves.
 - 2 x DN150 ball type non-return valves.
 - 2 x DN100 resilient seated gate valve.
 1 x DN225 resilient seated inlet gate valve.
- PIPEWORK DN150 Sch10 316 SS Pipework.
- 10. PUMPS Dual submersible pumps guiderail mounted.
- 11. ACCESS COVERS lockable hinged aluminium access covers with hinged safety
- grate over wet well

 12. LEVEL CONTROLS BY OTHERS
- PUMP CONTROLLER BY OTHERS
- 14. LIFTING DETAILS $4 \times 10.0t$ 'Swift-Lifts in base and $4 \times 5.0t$ in increments, valve chamber & coverslab.

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В	Inlet Chamber Removed	09.10.20
Α	For Approval	02.10.20
Rev	Description	Date

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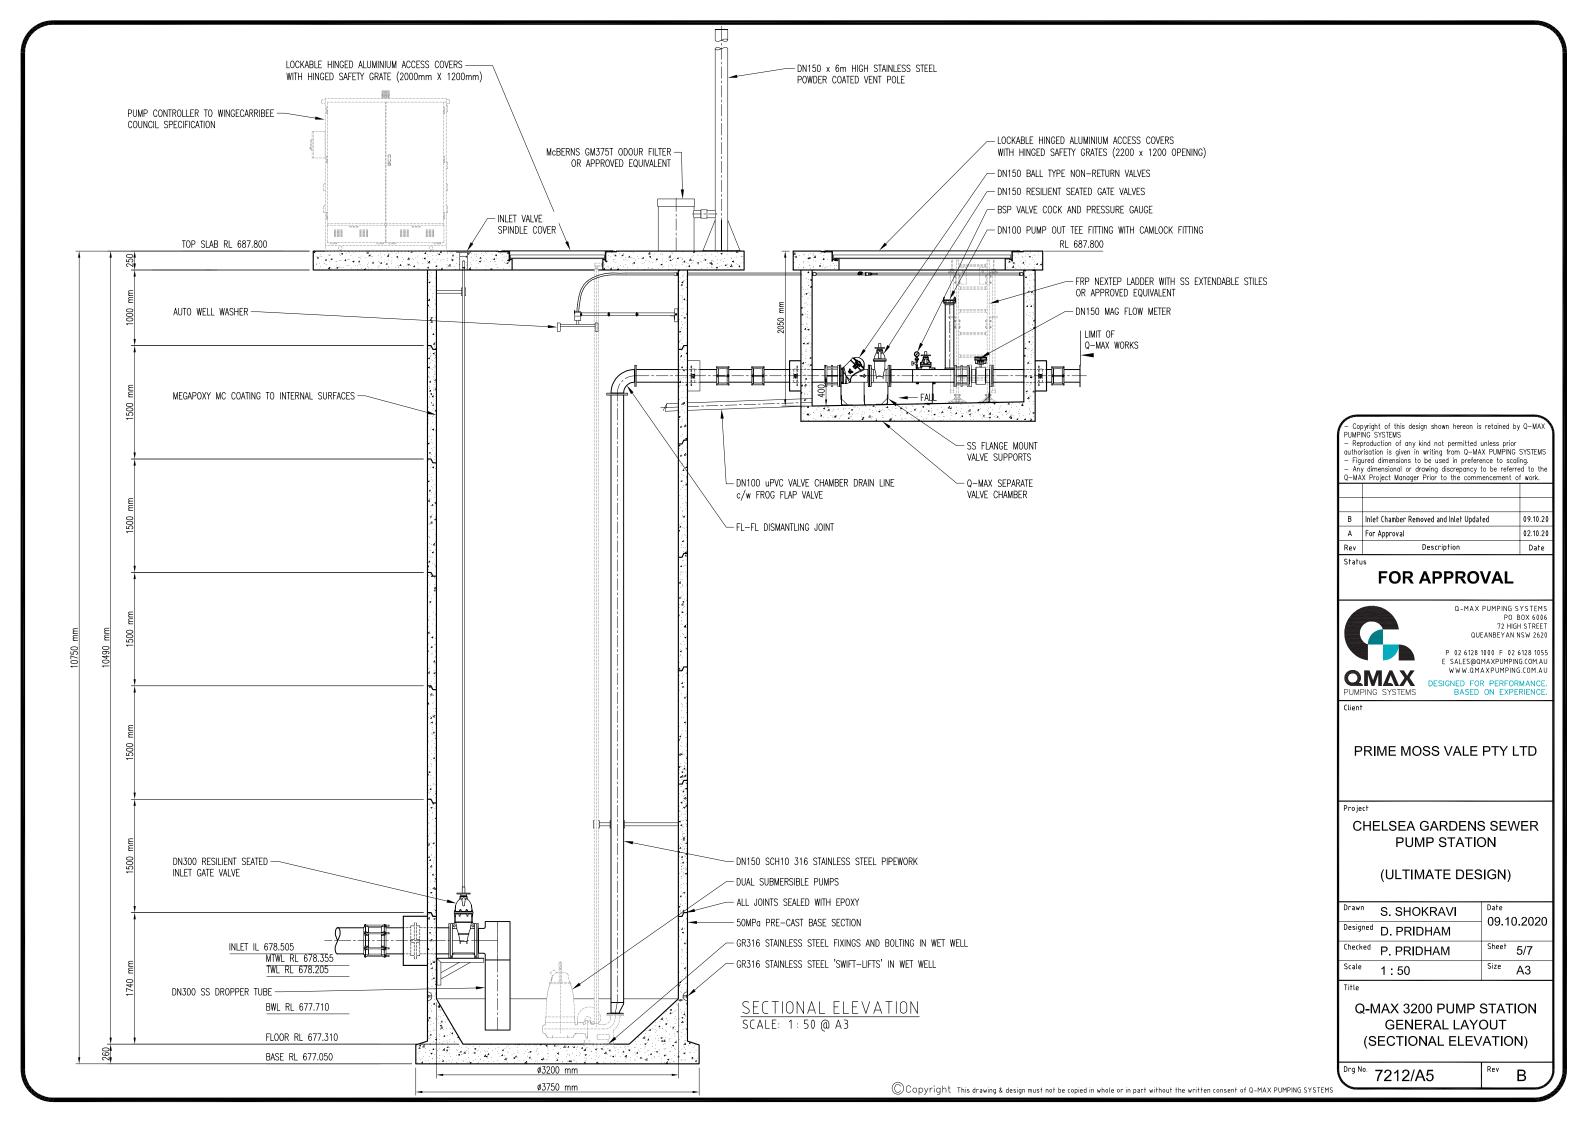
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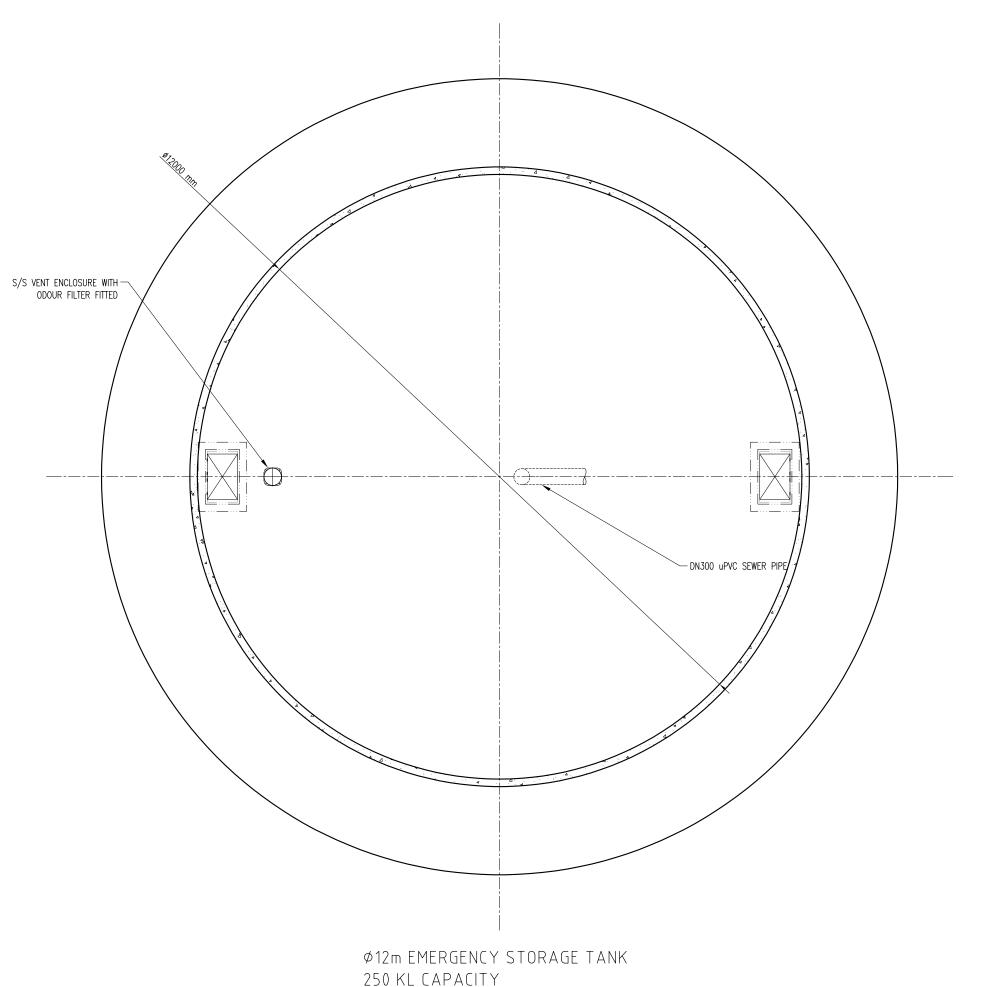
Drawn	S. SHOKRAVI	Date 00 40 0	2000
Designed	D. PRIDHAM	09.10	0.2020
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Scale	1:50	Size	А3

Q-MAX 3200 PUMP STATION **GENERAL LAYOUT** (PLAN VIEW)

T212/A4

В





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B EST Updated 30.08.21 A For Approval 02.10.20 Description Date

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CHELSEA GARDENS SEWER PUMP STATION


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Designed	D. PRIDHAM	30.0	0.202
Checked	P. PRIDHAM	Sheet	6/7
Scale	1:75	Size	А3

Q-MAX 3200 PUMP STATION 523KL CAPACITY EMERGENCY STORAGE TANK (PLAN VIEW)

В

Drg No. 7212/A6

250 KL CAPACITY PLAN VIEW SCALE: 1:75 @ A3

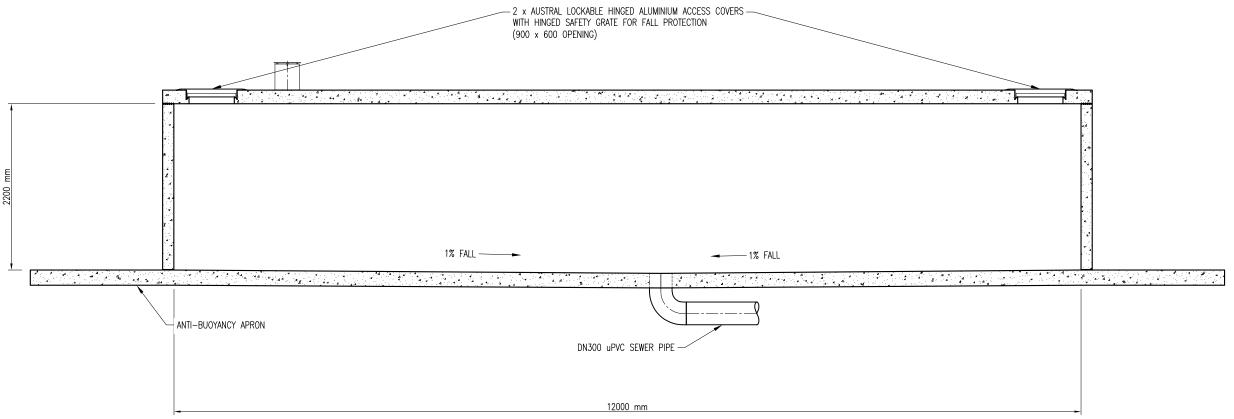

Ø12m EMERGENCY STORAGE TANK 250 KL CAPACITY ELEVATION SCALE: 1:50 @ A3

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	Α	For Approval	02.10.20
	Rev	Description	Date
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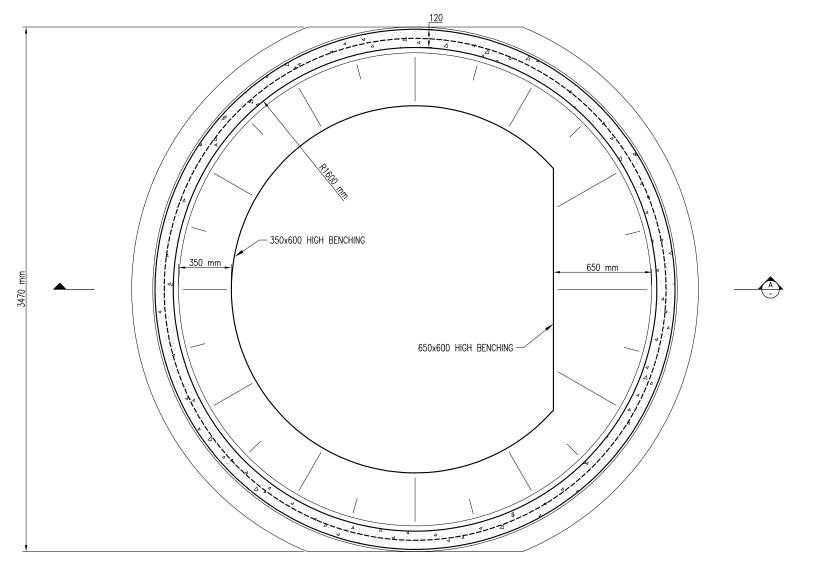
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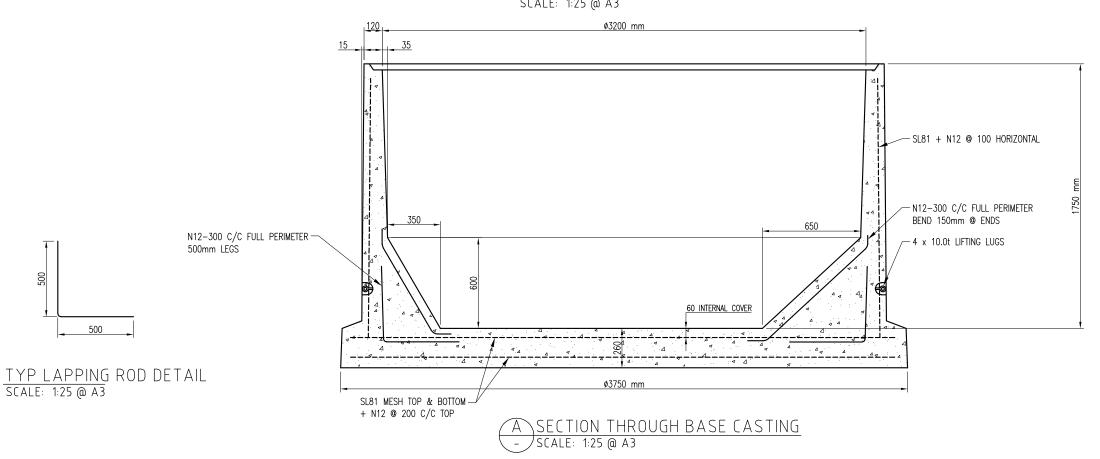
Drawn	S. SHOKRAVI	Date	8.202 ⁻
Designed	D. PRIDHAM	30.0	0.202
Checked	P. PRIDHAM	Sheet	7/7
Scale	1:50	Size	А3

Q-MAX 3200 PUMP STATION 523KL CAPACITY EMERGENCY STORAGE TANK (SECTIONAL ELEVATION)

Drg No. 7212/A7



TYP BASE CASTING PLAN SCALE: 1:25 @ A3



500

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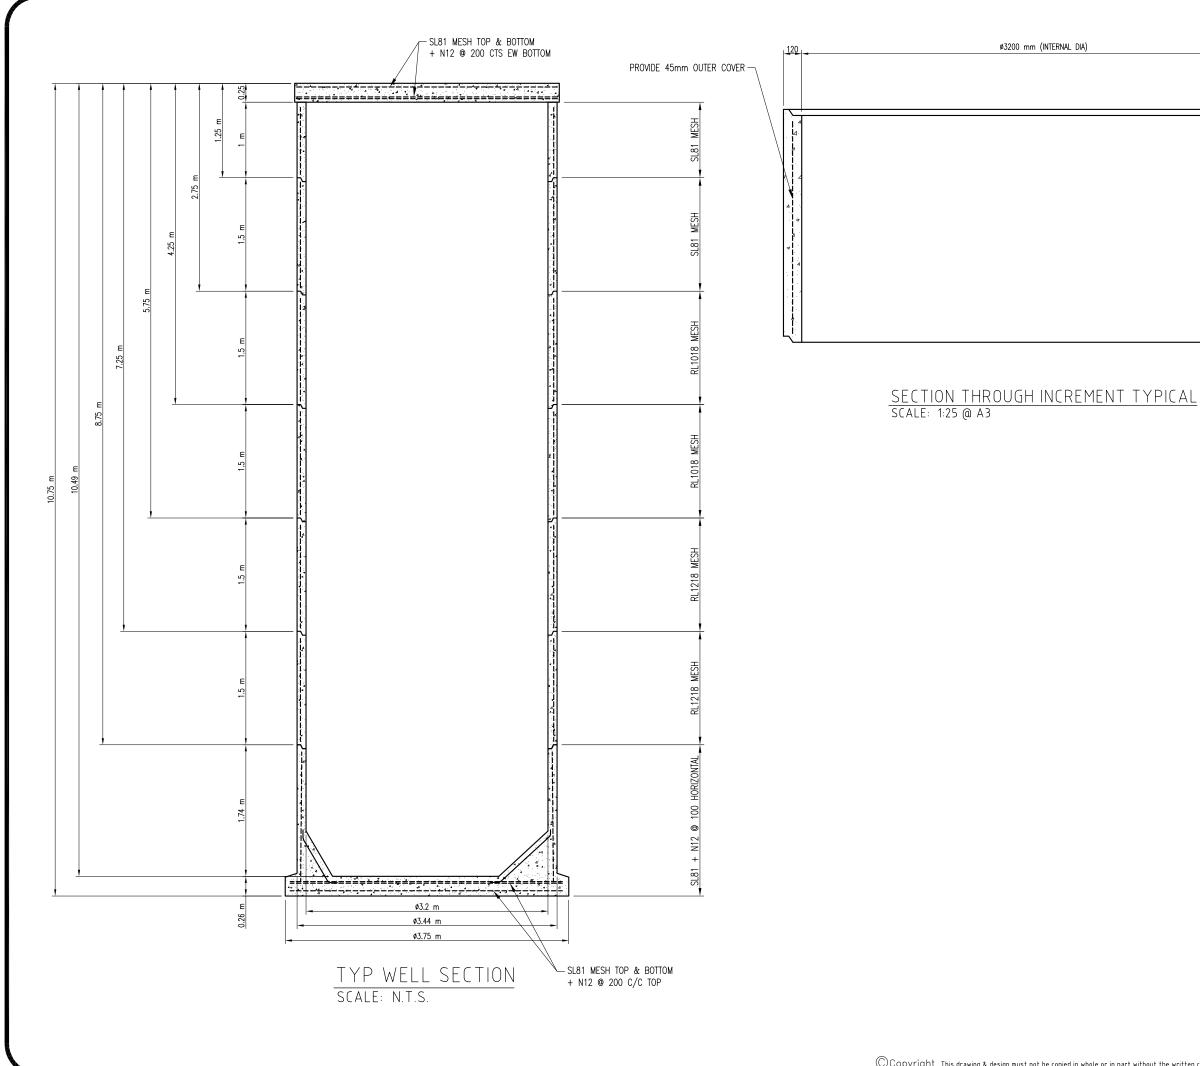
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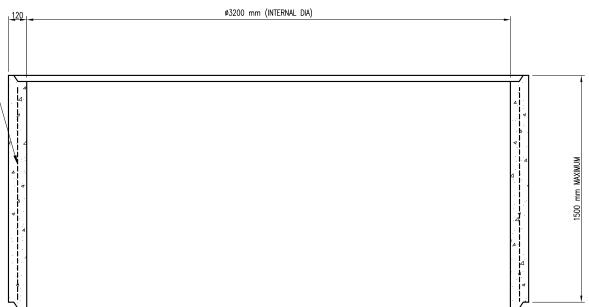
Drawn	S. SHOKRAVI	Date 17.08.2021
Designed	D. PRIDHAM	17.00.2021
Checked	P. PRIDHAM	Size A3

Q-MAX 3200 BASE SECTION CASTING REINFORCEMENT DETAIL

Scale 1:25 Rev Α

7212/R01





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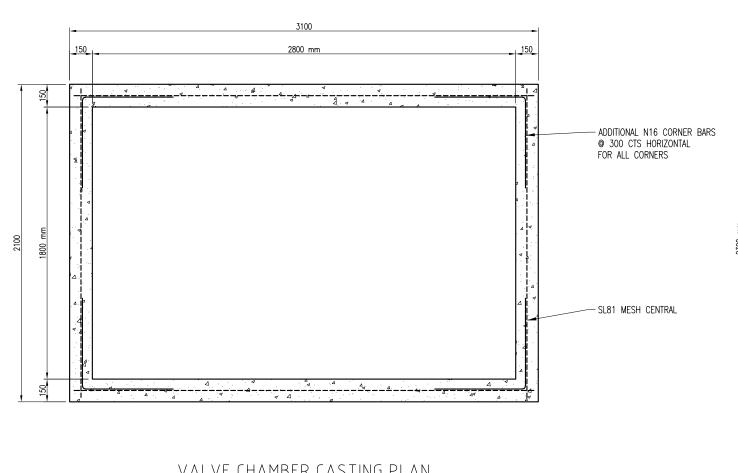
Drawn S. SHOKRAVI 17.08.2021 Designed D. PRIDHAM Size A3 Checked P. PRIDHAM

Q-MAX 3200 STANDARD **INCREMENT CASTING** REINFORCEMENT DETAIL

Rev A

N.T.S.


7212/R02



SL81 TOP & BOTTOM -2200 (Clear Opening)

VALVE CHAMBER COVER SLAB PLAN SCALE: 1:25 @ A3

VALVE CHAMBER CASTING PLAN SCALE: 1:25 @ A3

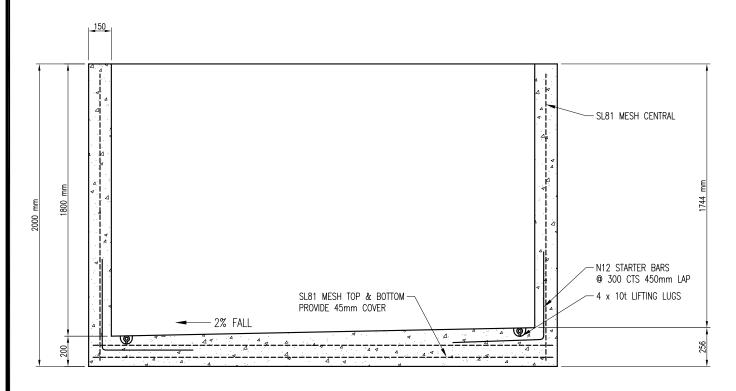

SECTION THROUGH VALVE CHAMBER SCALE: 1:25 @ A3

-SL81 MESH TOP & BOTTOM

VALVE CHAMBER COVER SLAB SECTION SCALE: 1:25 @ A3

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3Nos N12 x 1000 LONG DIAGONAL TOP FACE CRACK CONTROL (TO INSERT COVERS)

- ADDITIONAL N16 TOP & BOTTOM

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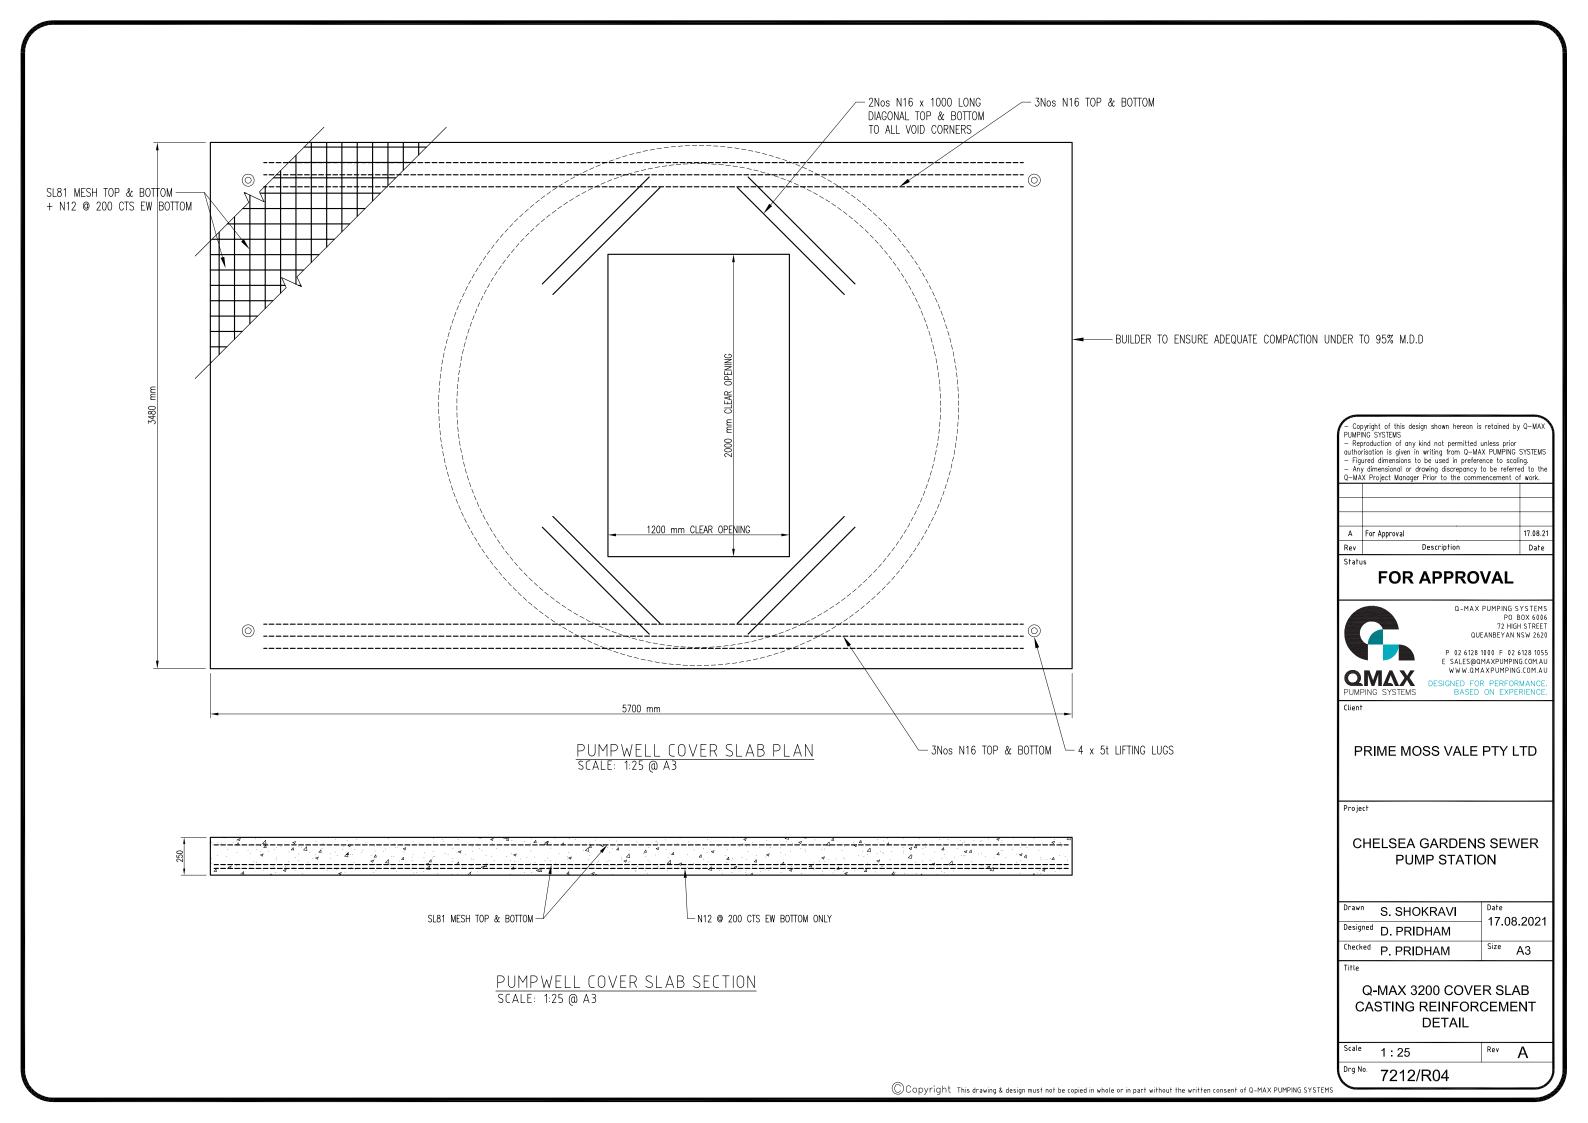
CHELSEA GARDENS SEWER **PUMP STATION**


Drawn	S. SHOKRAVI	Date 17 00 20	2021	
Designed	D. PRIDHAM	17.08.202 ⁻)	
Checked	P. PRIDHAM	Size A3		

Q-MAX 3200 VALVE CHAMBER CASTING REINFORCEMENT DETAIL

Scale 1:25 Rev A

7212/R03



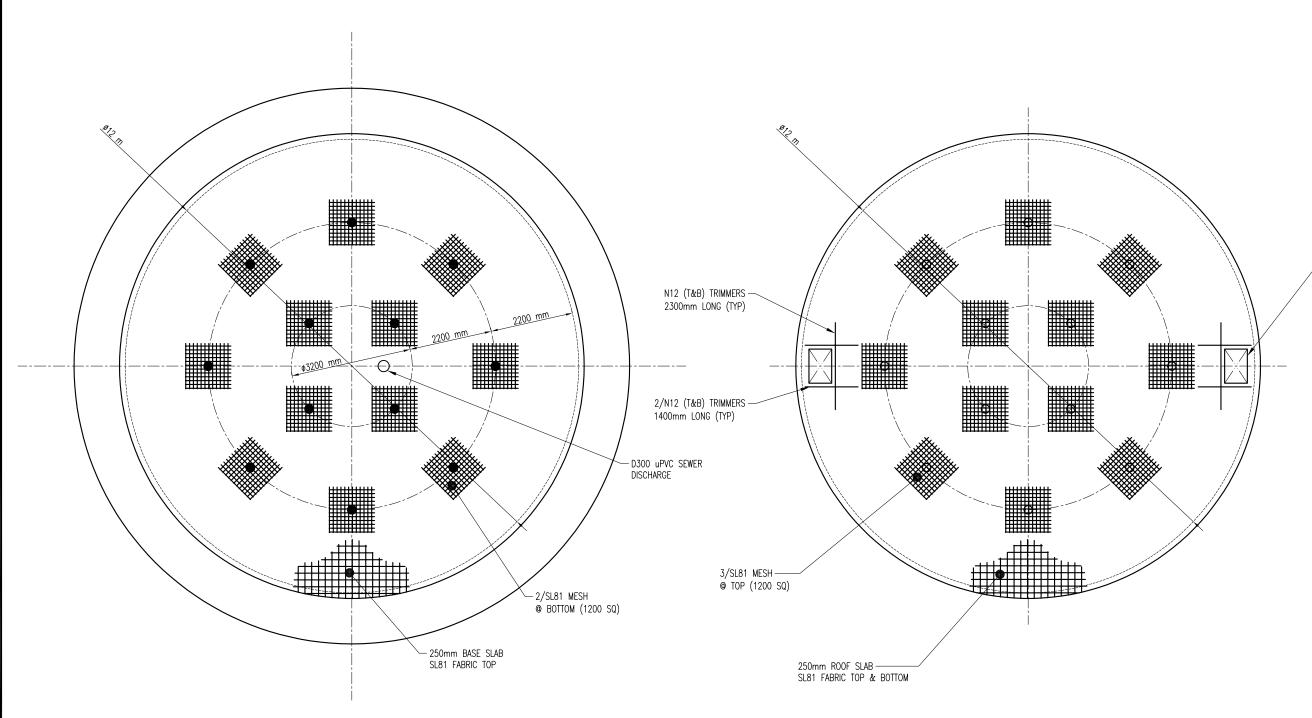

Ø12m EMERGENCY STORAGE TANK 250 KL CAPACITY PLAN VIEW SCALE: 1:100 @ A1

- 900 x 600 ACCESS COVER

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CHELSEA GARDENS SEWER **PUMP STATION**


	Drawn	S. SHOKRAVI	Date 27.08.2021	
	Designed	D. PRIDHAM		
	Checked	P. PRIDHAM	Size	А3

Q-MAX Ø12m 250KL **EMERGENCY STORAGE TANK** REINFORCEMENT DETAILS SECTIONAL PLAN VIEW

Scale 1:100

7212/R05

- BASE & WALLS TO BE 40MPa CONCRETE, ROOF & COLUMNS TO BE 40MPa CONCRETE, MAX 20mm AGGREGATE TO AS 3600.
- 2. MINIMUM ALLOWABLE BEARING PRESSURE SOIL UNDER THE TANK TO BE 150 kPa.
- THE MAXIMUM TANK INTERNAL WALL HEIGHT TO BE 2200mm.
 MAXIMUM LIVE LOAD APPLIED ON THE TANK TO BE 5KPa.
- THE STRUCTURE HAS BEEN DESIGNED TO AS 3600 & AS 3735 CONCRETE STRUCTURES FOR RETAINING LIQUIDS.
- 6. MINIMUM FABRIC SPLICE TO BE 250mm.
- 7. CONCRETE COVER TO REINFORCEMENT TO BE 50mm & 65mm @ AIR/WATER FACE.
- 8. PROVIDE 2/N12 TRIMMERS (40FF) AROUND ANY WALL PENETRATIONS
- 9. THE TANK HAS BEEN DESIGNED FOR BUOYANCY FOR FLOOD LEVELS @ TOP OF TANK ROOF AT NATURAL 1 FVF1.

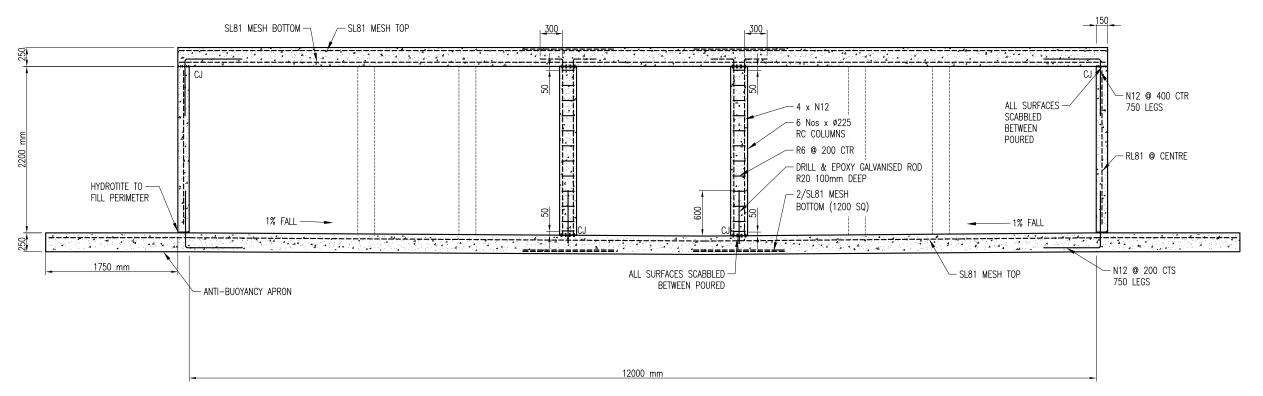

Φ12m EMERGENCY STORAGE TANK 250 KL CAPACITY ELEVATION SCALE: 1:50 @ A3 Copyright of this design shown hereon is retained by Q-MAX PUMPING SYSTEMS

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Rev Description Date

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Client

PRIME MOSS VALE PTY LTD

Project

CHELSEA GARDENS SEWER PUMP STATION

| Drawn | S. SHOKRAVI | 27.08.2021 | | Designed | D. PRIDHAM | Size | A3 | |

Title

Q-MAX Ø12m 250KL EMERGENCY STORAGE TANK REINFORCEMENT DETAILS SECTIONAL ELEVATION

Scale 1:50 Rev

Org No. 7212/R05